


W.1: 2No. New external Proposed external aluminium single leaf window, inward opening side hung window.

- Colour to match existing windows Brown/Grey.
- Clear glass/single glazing
   Contractor to check on site structural opening size prior to
- Monufacturer to provide suitable frame section.

  Monufacturer and reference: Technol or similar approved, all to relevant & current BS. Clauses.
- Ironmongery/accessories: As supplied by manufacturer.

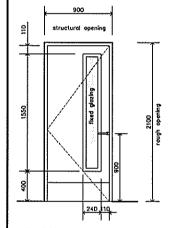


D1: FD30

- 2No. Note:
- Contractor to check on site structural opening size prior to fabrication. softwood painted

- internal only
   vision panel Georgian wire, single
- glazes

   kick plate internal face

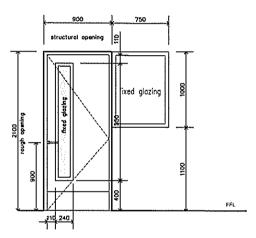


- Note:

  Contractor to check on site structural opening size prior to fabrication.

  softwood pointed

  internal only

  vision panel Georgian wire, single glazing
  kick plate internal face

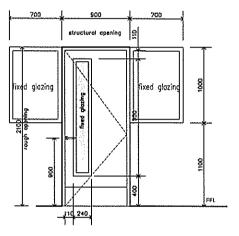

- Note:

  Contractor to check on site structural opening size prior to fabrication.

  softward pointed

  internal only
  vision panel Georgian wire, single glazing
  kick plate internal face

This drawing is the copyright and property of AKS Architects and Engineers Ltd. It must not be copied or published without written consent. Do not scale from this drawing.

All dimensions to be checked on site.

## TOWN PLANNING AND BUILDING CONTROL

3 1 JAN 2014

# RECEIVED

01.14 issued to planning rev date description



ARCHITECTS & ENGINEERS P.O. Box 855, Gibrolton


Tel: (+350) 20073260 Fox: (+350) 20074739 Email: mail@aks.gi

project


Internal Alterations to Housing Works Agency

Architectural GA: Door & Window Schedule

scole 1: 25@A1 1:50@A3 DJR DJR drawing no. 23.01.14 A214004.102

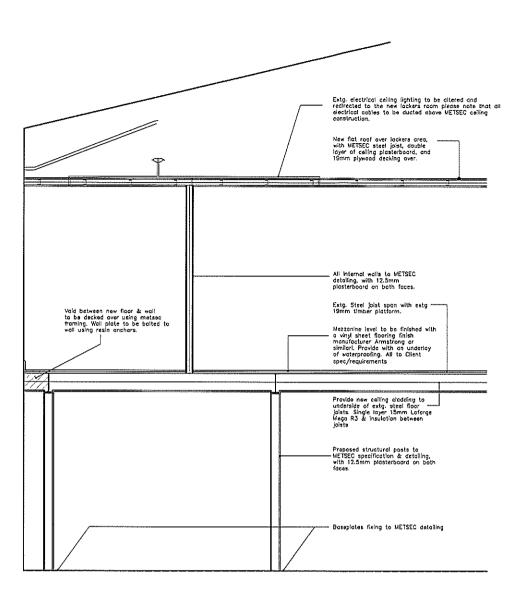

Typical Party wall Section scale 1:25

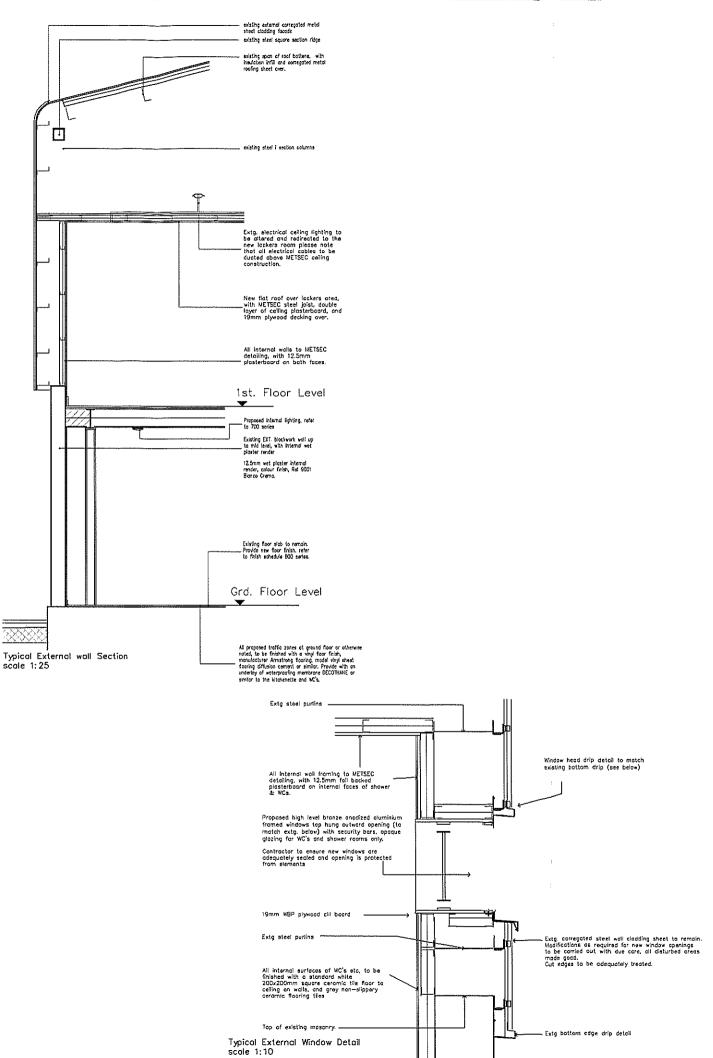

This drawing is the copyright and property of AKS Architects and Engineers Ltd. It must not be copied or published without written consent. Do not scale from this drawing.

All dimensions to be checked on site.

### TOWN PLANNING AND **BUILDING CONTROL**

3 1 JAN 2014

## RECEIVED

A 01.14 issued to planning rev | date | description



ARCHITECTS & ENGINEERS P.O. Box 855, Gibraltor


Tel: (+350) 20073260 Fox: (+350) 20074739 Emoil: mail@aks.gi


project


Internal Alterations to Housing Works Agency


Architectural GA: General Detail & Sections


scole 1: 25/10@A1 1:50/20@A3 DJR DJR drawing no. A214004.103 23.01.14

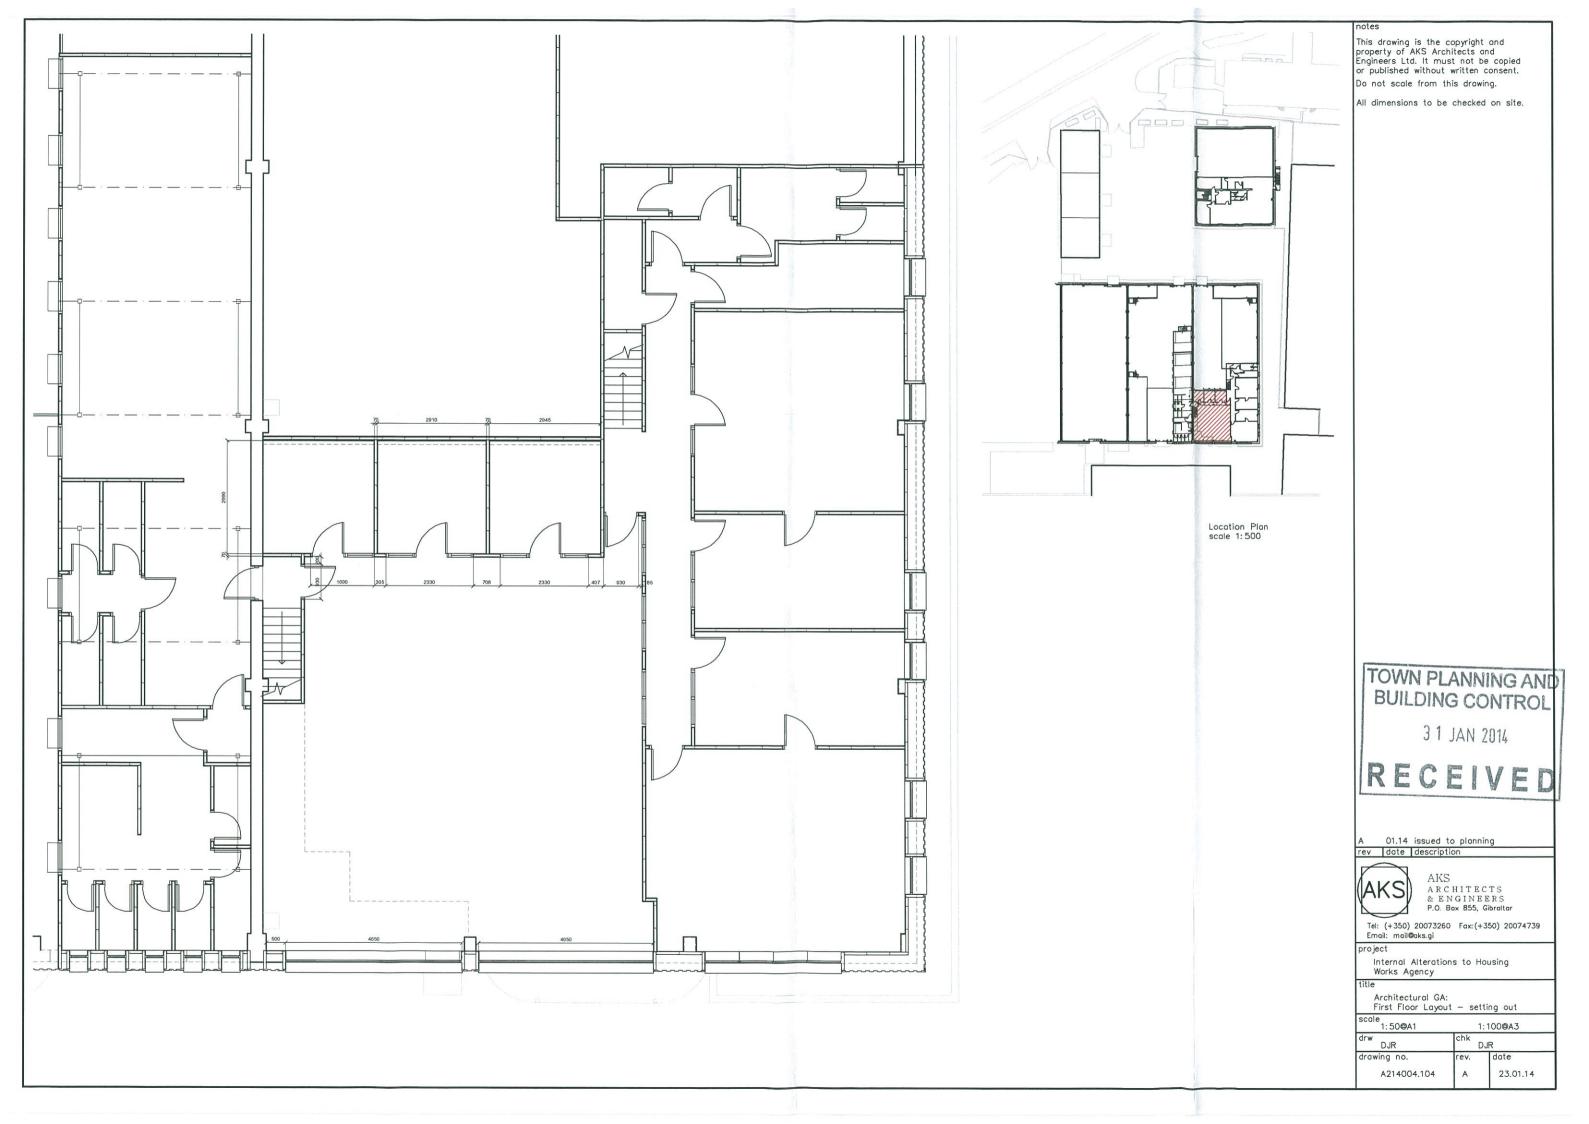


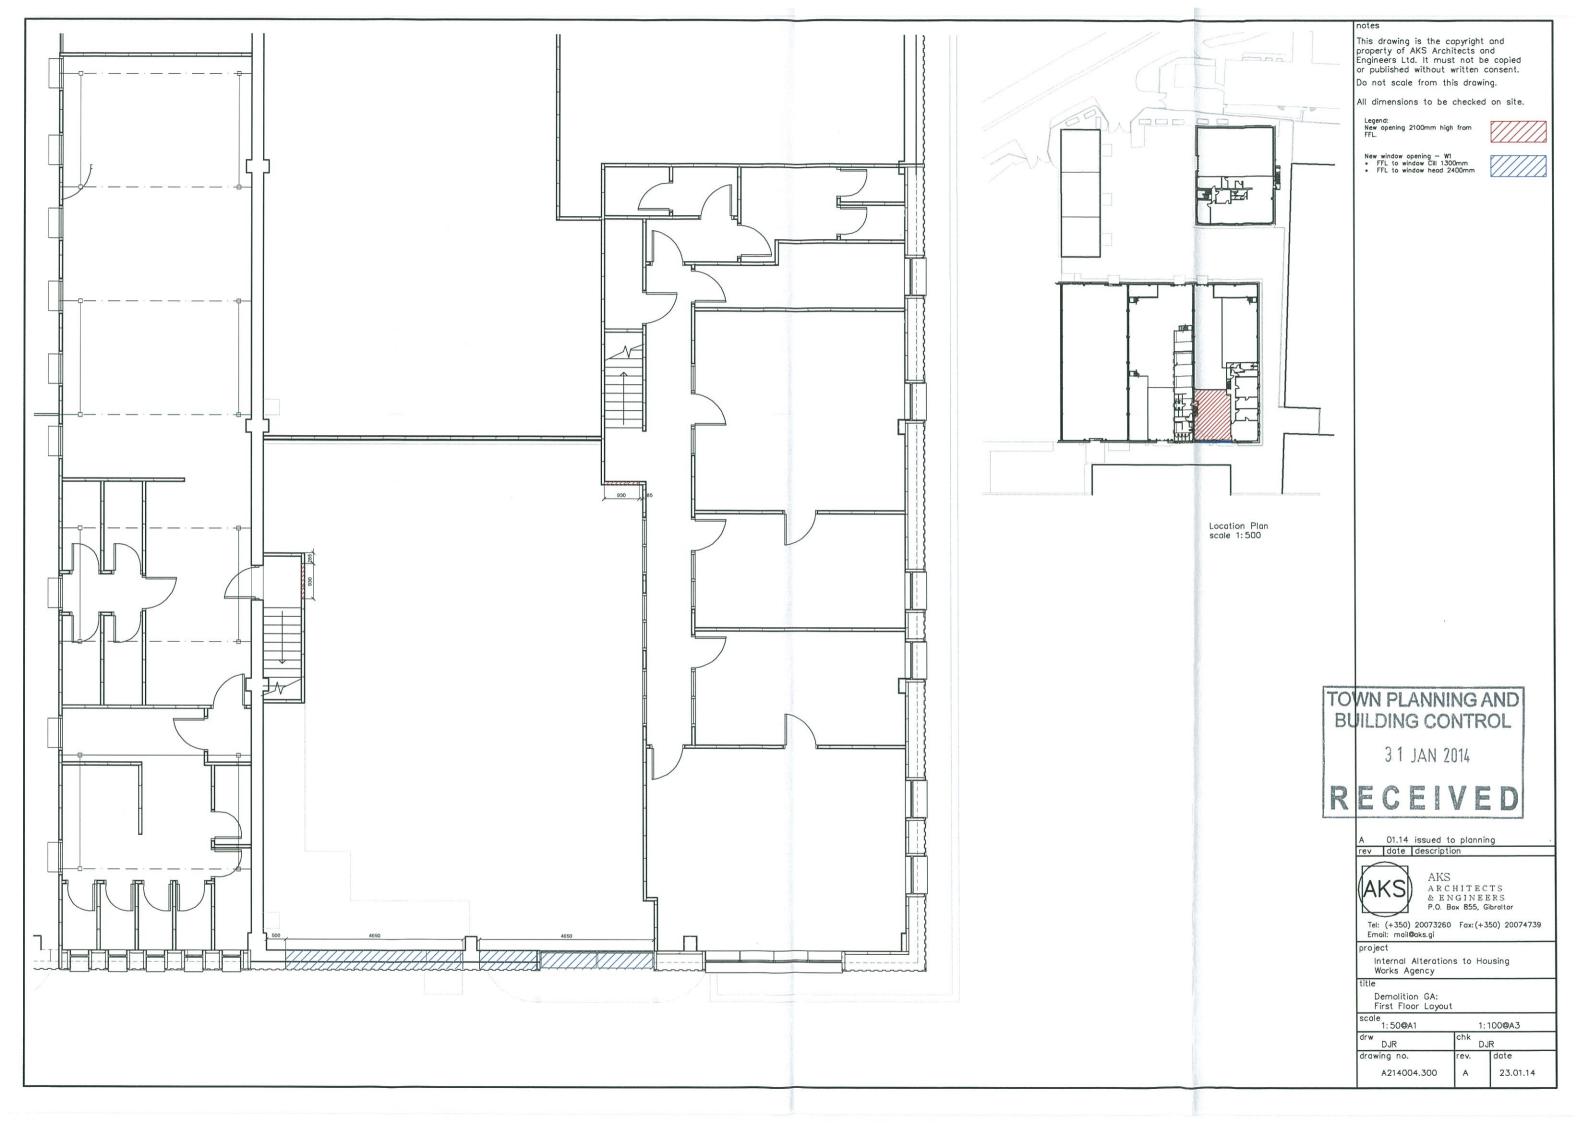


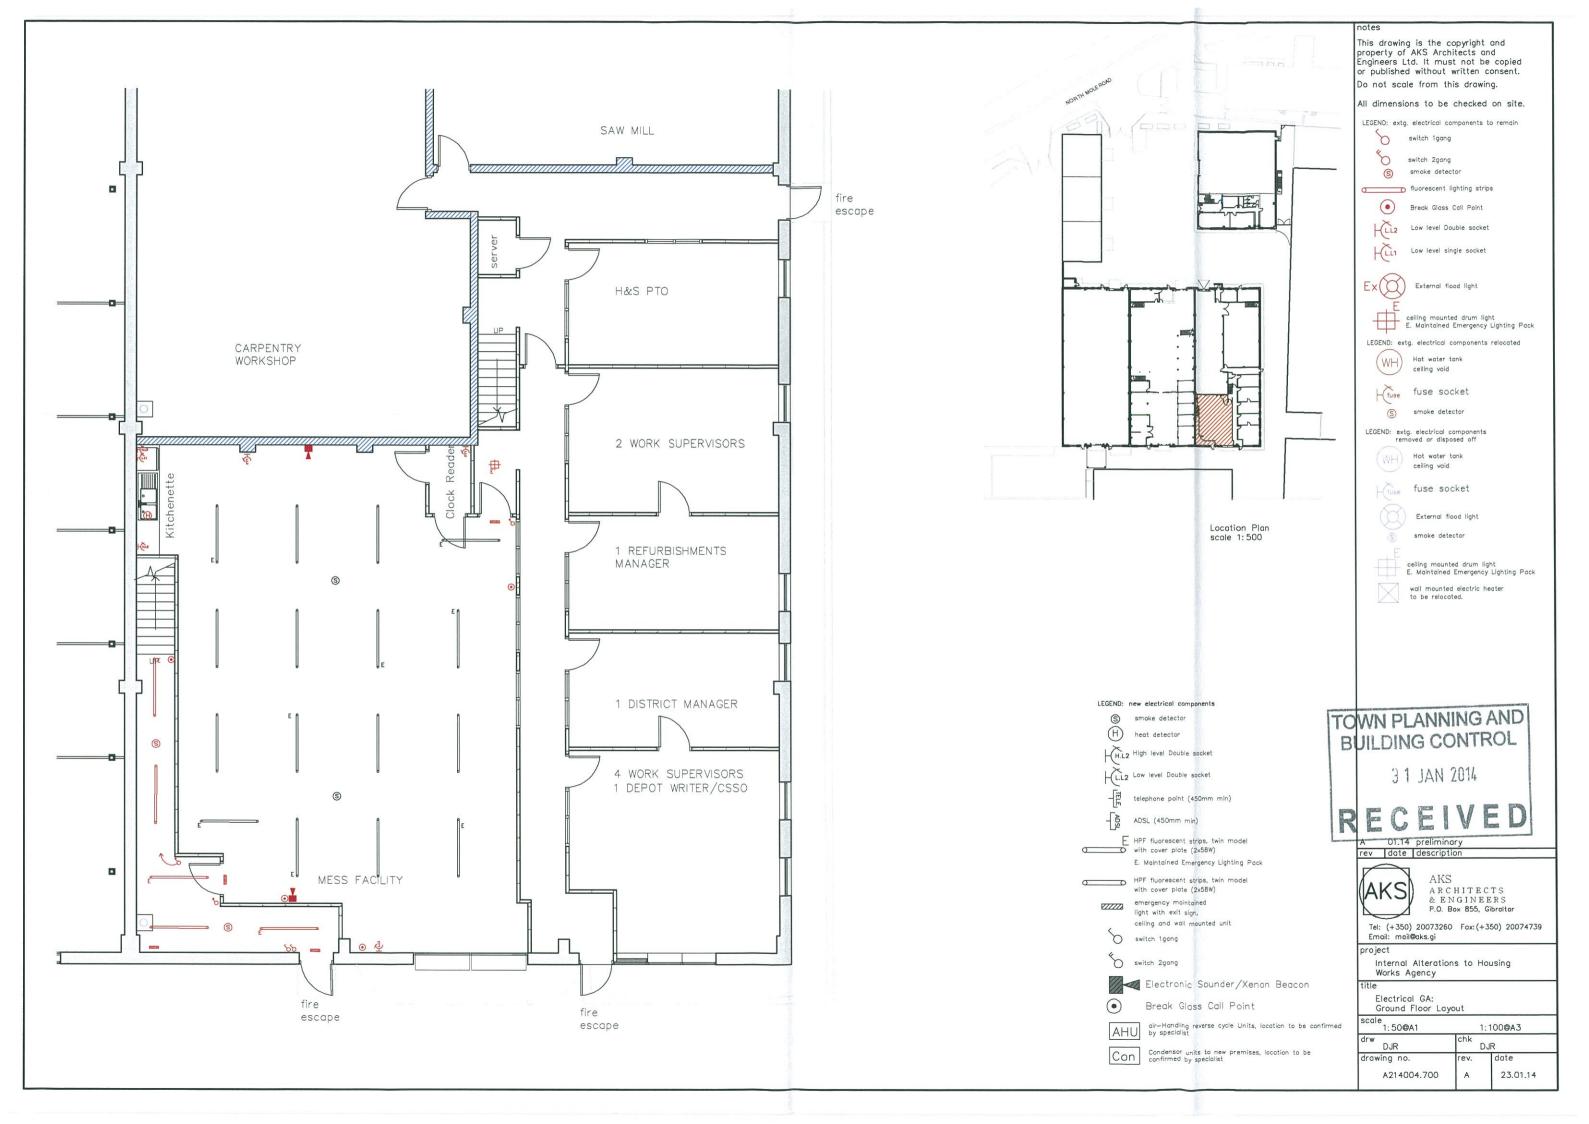


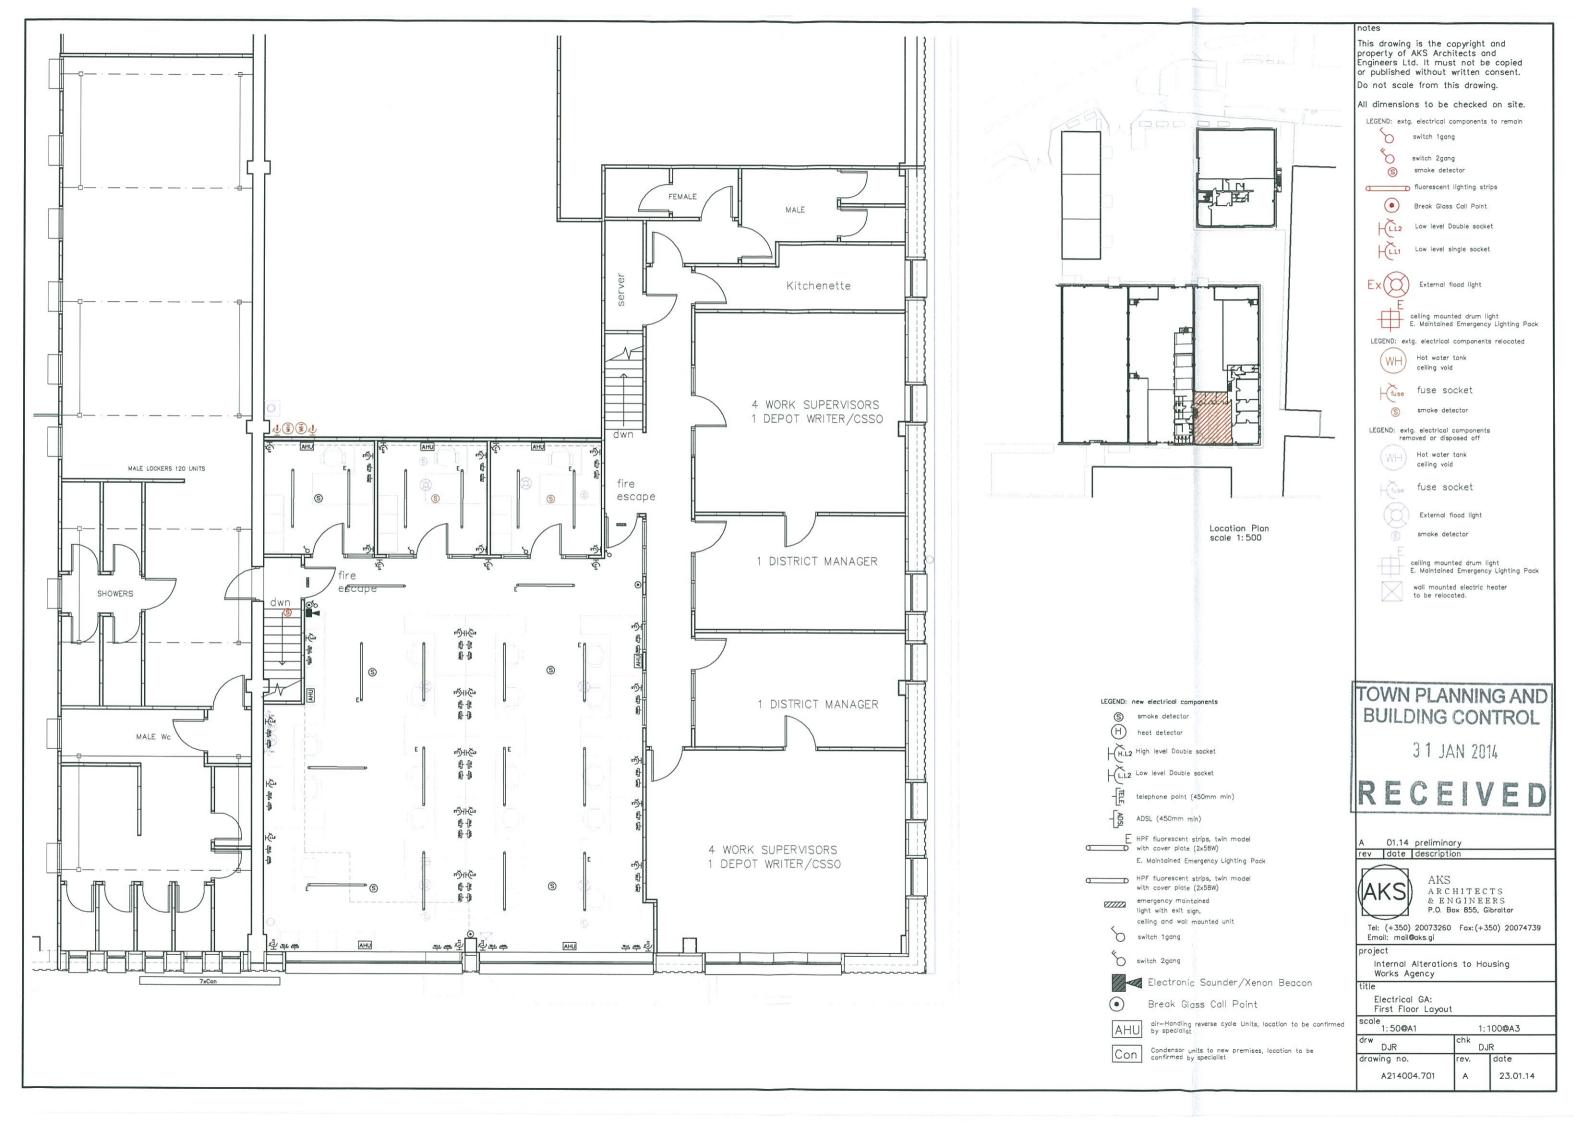


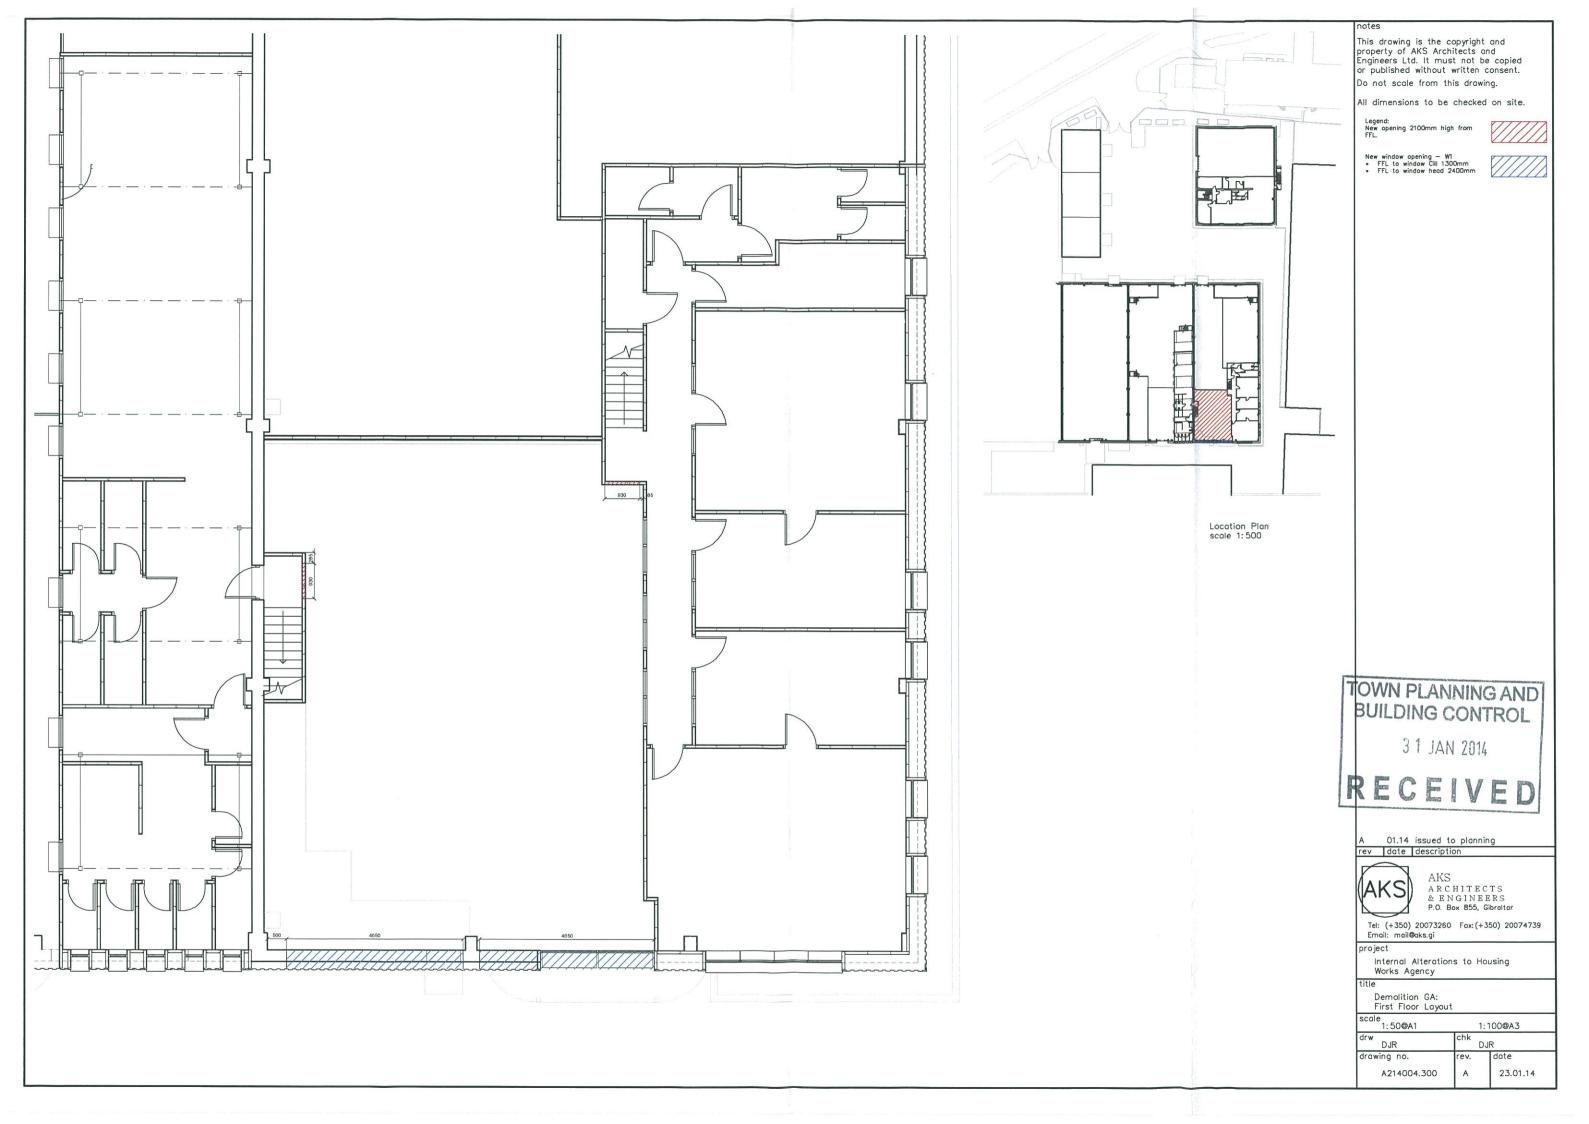

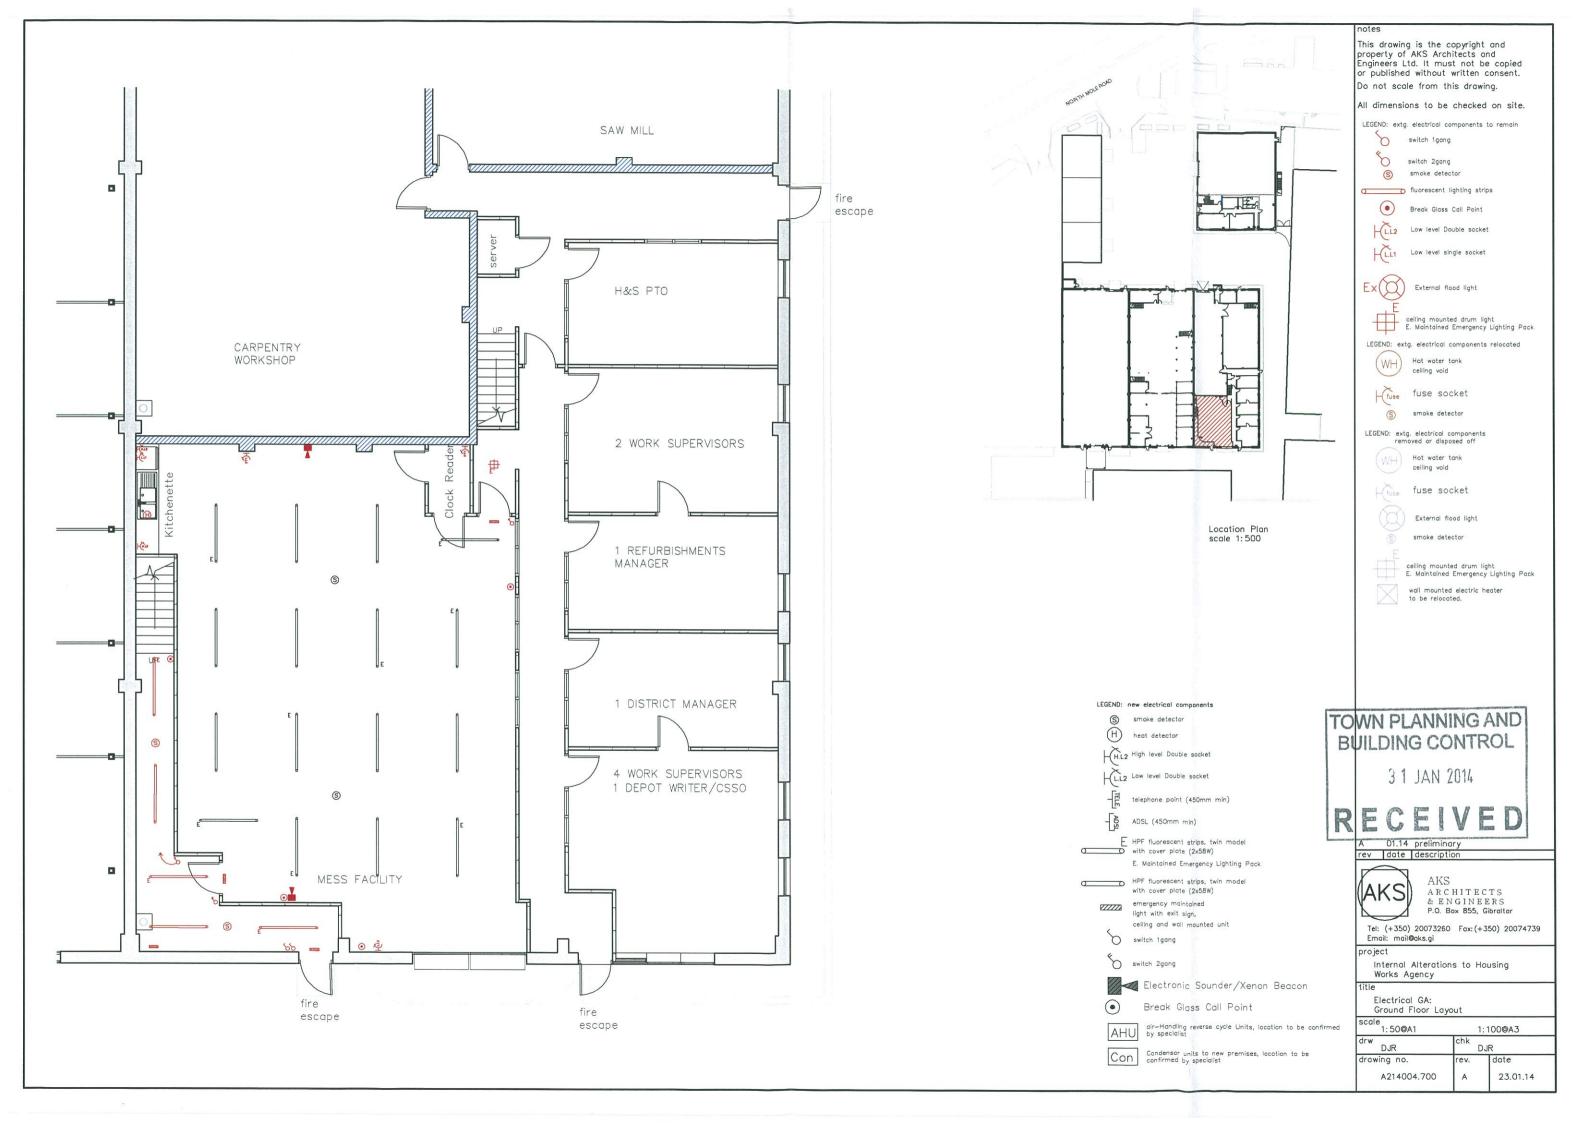

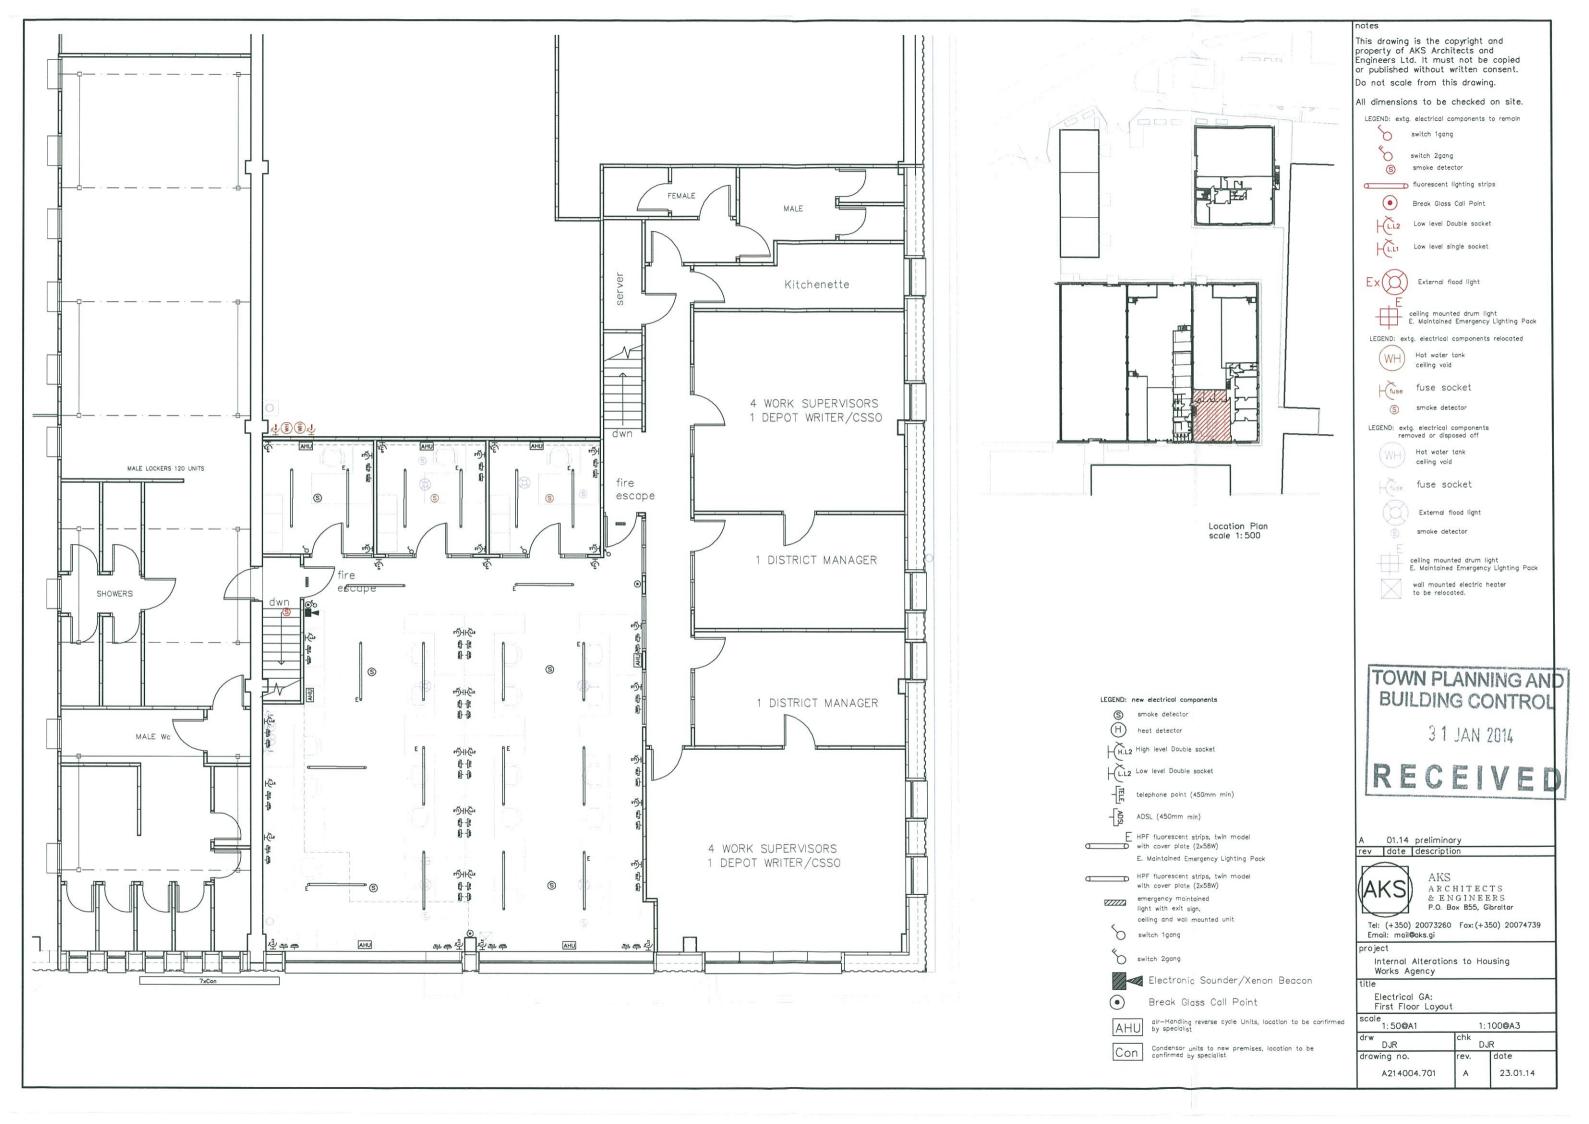

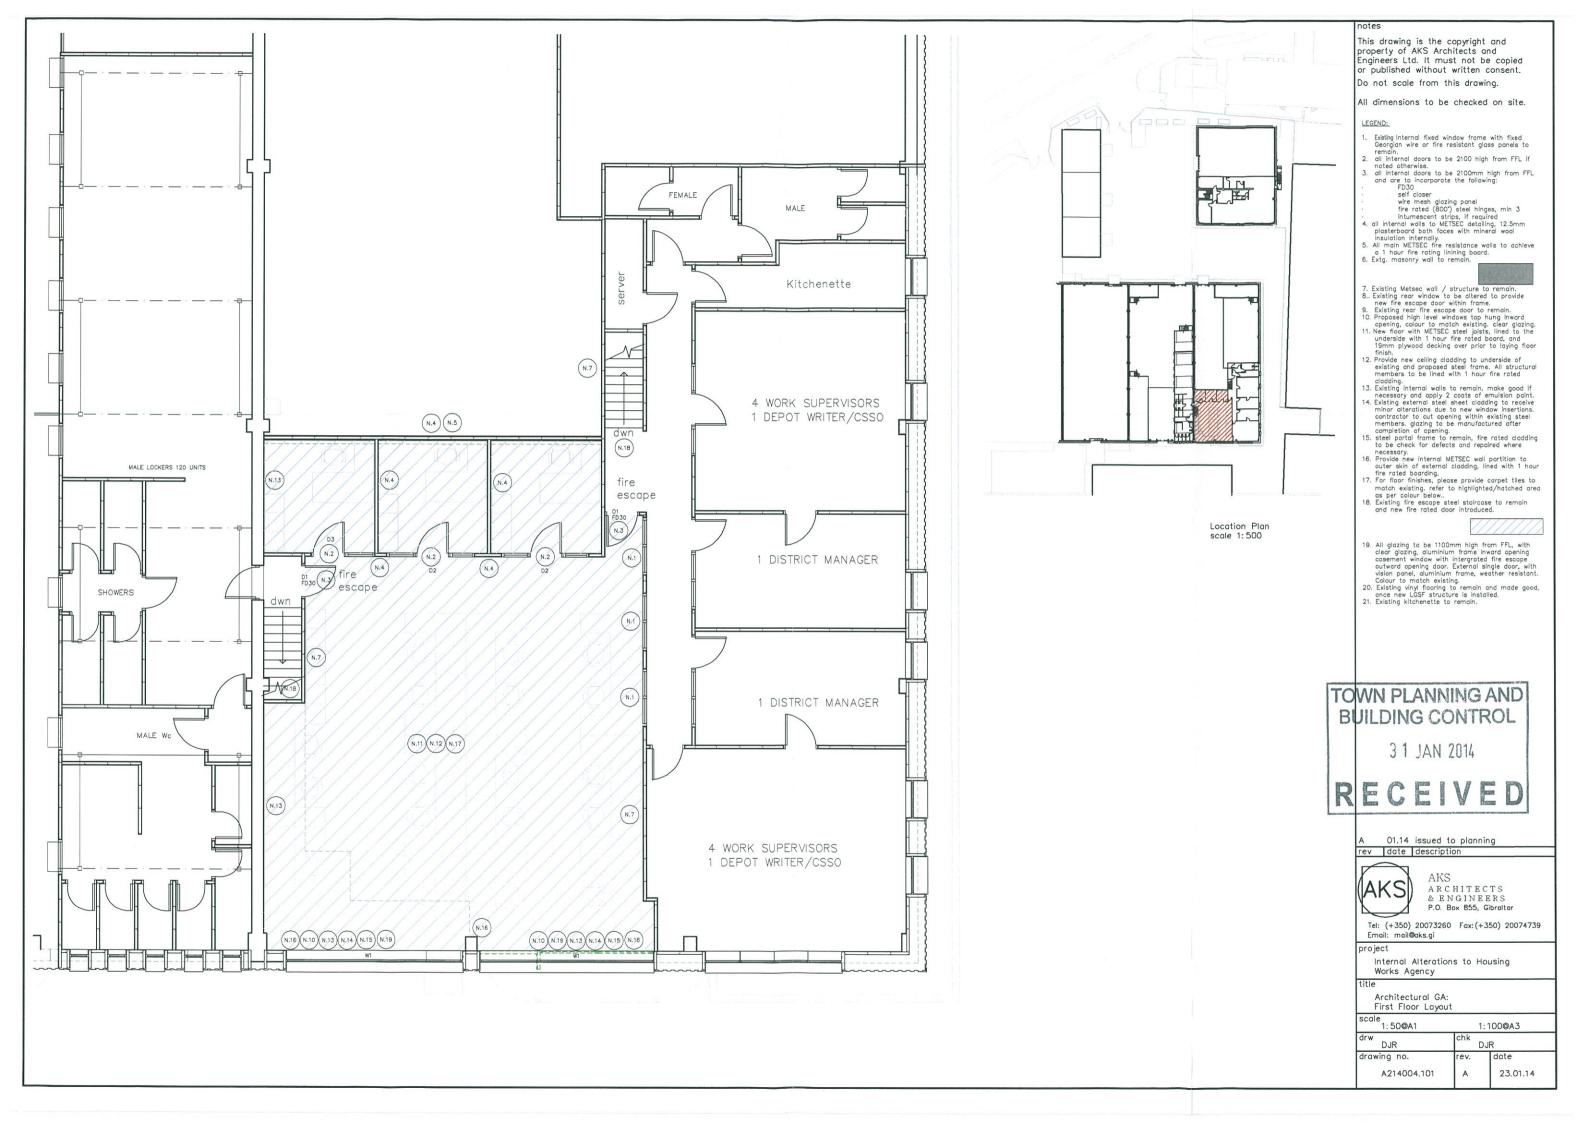

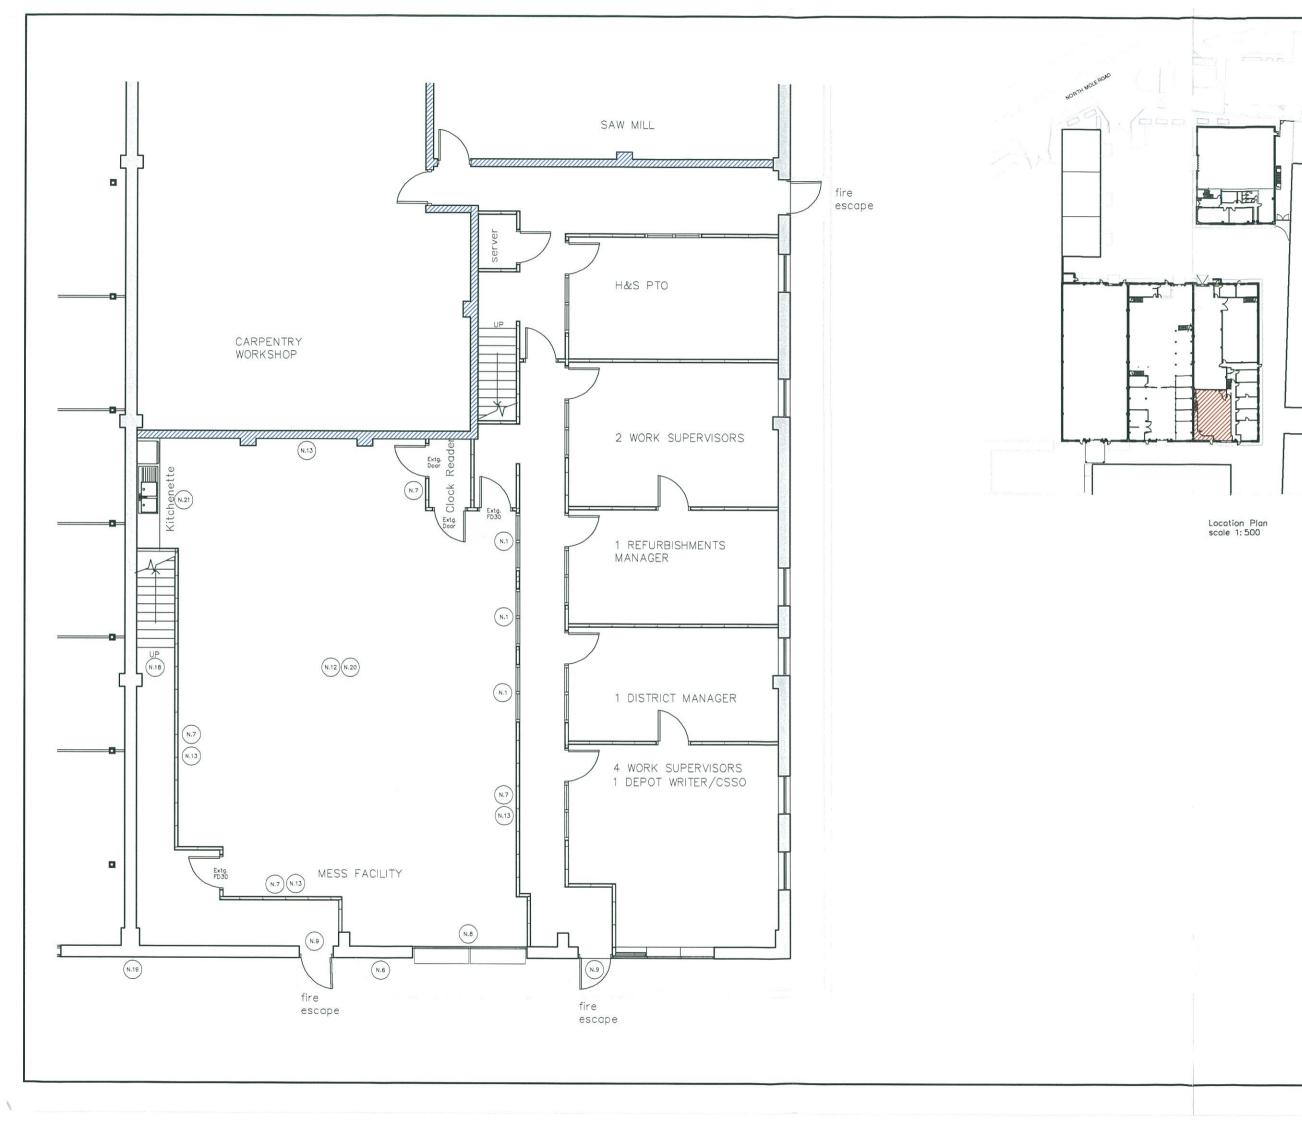

This drawing is the copyright and property of AKS Architects and Engineers Ltd. It must not be copied or published without written consent. Do not scale from this drawing.

All dimensions to be checked on site.

## LEGEND:

- LEGEND:

  1. Existing internal fixed window frame with fixed Georgian wire or fire resistant glass panels to remain.

  2. all internal doors to be 2100 high from FFL if noted otherwise.

  3. all internal doors to be 2100mm high from FFL and are to incorporate the following:

  FD30

  self closer
  wire mesh glazing panel
  fire rated (800") steel hinges, min 3
  intumescent strips, if required

  4. all internal walls to METSEC detailing, 12.5mm plosterboard both faces with mineral wool insulation internally.

  All main METSEC fire resistance walls to achieve a 1 hour fire rating linining board.

  6. Extg. masonry wall to remain.

- 7. Existing Metsec wall / structure to remain.
  8. Existing rear window to be altered to provide new fire escape door within frame.
  9. Existing rear fire escape door to remain.
  10. Proposed high level windows top hung inward opening, colour to match existing, clear glazing.
  11. New floor with METSEC steel joists, lined to the underside with 1 hour fire rated board, and 19mm plywood decking over prior to laying floor finish.
  12. Provide new ceiling cladding to underside of existing and proposed steel frame. All structural members to be lined with 1 hour fire rated cladding.
- members to be lined with 1 hour fire rated cladding.

  13. Existing internal walls to remain, make good if necessary and apply 2 coats of emulsion paint.

  14. Existing external steel sheet cladding to receive minor alterations due to new window insertions. contractor to cut opening within existing steel members, glazing to be manufactured after completion of opening.

  15. steel portal frame to remain, fire rated cladding to be check for defects and repaired where necessary.
- to be check for defects and repaired where necessary.

  16. Provide new internal METSEC wall partition to outer skin of external cladding, lined with 1 hour fire rated boarding, because provide carpet tiles to match existing, refer to highlighted/hatched area as per colour below.

  18. Existing fire escape steel staircase to remain and new fire rated door introduced.

- 19. All glazing to be 1100mm high from FFL, with clear glazing, aluminium frame inward opening casement window with intergrated fire escape outward opening door. External single door, with vision panel, aluminium frame, weather resistant. Colour to match existing.
  20. Existing vinyl flooring to remain and made good, ance new LGSF structure is installed.
  21. Existing kitchenette to remain.



01.14 issued to planning

rev date description



ARCHITECTS P.O. Box 855, Gibraltar

Tel: (+350) 20073260 Fax: (+350) 20074739 Email: mail@aks.gi

### project

Internal Alterations to Housing Works Agency

Architectural GA: Ground Floor Layout

1:50@A1	1:50@A1 1:100@A3	
drw DJR		
drawing no.	rev.	date
A214004.100	Α	23.01.14